General Notes:

1. Design Specifications: International Building Code (2012 Edition).

Existing drain –

Existing sky light

Existing Fan

West

- Design Loads:
 - Dead load: 15 PSF
 - Roof Live Load: 20 PSF Risk Category: II
- Exposure Category: B
- 2. The construction falsework / shoring design (if any) is the responsibility of the Contractor. The design shall be performed by a Registered Engineer and shall be submitted for approval before commencing of the work.
- 3. Where a detail is shown on Structural drawings for one condition, it shall apply to all similar or like conditions, unless noted or shown otherwise on plans.
- 4. All items shall be tightly anchored or attached square, plumb, and true, or in other planes and shapes as shown on the drawings. Joints shall be tight, even, and free of offsets. No field altering of any members will be allowed that will cause them not to be in accordance with the drawings and specifications, without written approval of the Project Engineer.
- 5. The dimensions shown with a suffix "±" are approximate and shall be verified by the Contractor before fabrication.
- 6. If the Contractor finds a difference between these drawings & existing conditions, or finds any other conditions which prohibit execution of the work as directed in these drawings,
- the Contractor shall notify the Engineer immediately.
- 7. Any revision/modification to the original design during the shop drawing process, the Contractor shall clearly cloud line all the changes and shall receive approval from the Engineer in writing before fabrication. Any costs associated with correcting the unapproved change shall be at the Contractor's expense.
- 8. All products used are recommended. Any other product to be used must be equal and approved by the Engineer.
- 9. Required measures shall be taken to allow a safe work and public environment in and near the construction site.

Metal Framing (light gage):

- 1. All metal framing shall be designed, fabricated and erected in accordance with the American Iron and Steel Institute's "Specification for the Design of Cold Formed Steel Structural Members."
- 2. Metal framing shall be of the size, gage and section properties indicated on the drawing or as required for the specific loading condition. The deflection limit of the exterior studs subject to wind load is L/600.
- 3. All welding of metal framing shall be performed by certified welders experienced in the welding of light gage members.
- 4. All metal framing shall be saw cut, square and true. Cutting of metal framing with a torch will not be permitted.

Light feature,

needed

camera and conduit

shall be temporarily

removed, adjusted

and/or reinstalled as

5. Prior to proceeding w/ any metal framing work, the Contractor shall submit to the Architect/Engineer, for approval, shop drawings showing the size, location & connection details of all load bearing metal framing and all exterior framing. Shop drawings shall include a plan and elevation of all wall or soffit framing and connection details. The Contractor shall also submit calculations prepared and sealed by a Professional Engineer registered in the State of South Carolina which demonstrate that all applied loads will be resisted by the supplied framing system.

G. C. shall field verify all conflict utility, removed and relocate as required for repair

Note: Existing roof materials shall be removed prior to installing new roof, see 5/S1.2

Note: Contractor to provide pre-approved siding material at gable ends of roofs, typ.



∞

Plan

Condition

Columbia,

Existing fan -

- Light feature,

needed

camera and conduit

shall be temporarily

and/or reinstalled as

removed, adjusted

Exsiting drain -

Existing condition (Top view) Scale: 1/2" = 1'-0"

Existing drain Existing sky light 12"±


East

Existing Fan

nd Existing Co rking Garage 0

April 8, 2019

West

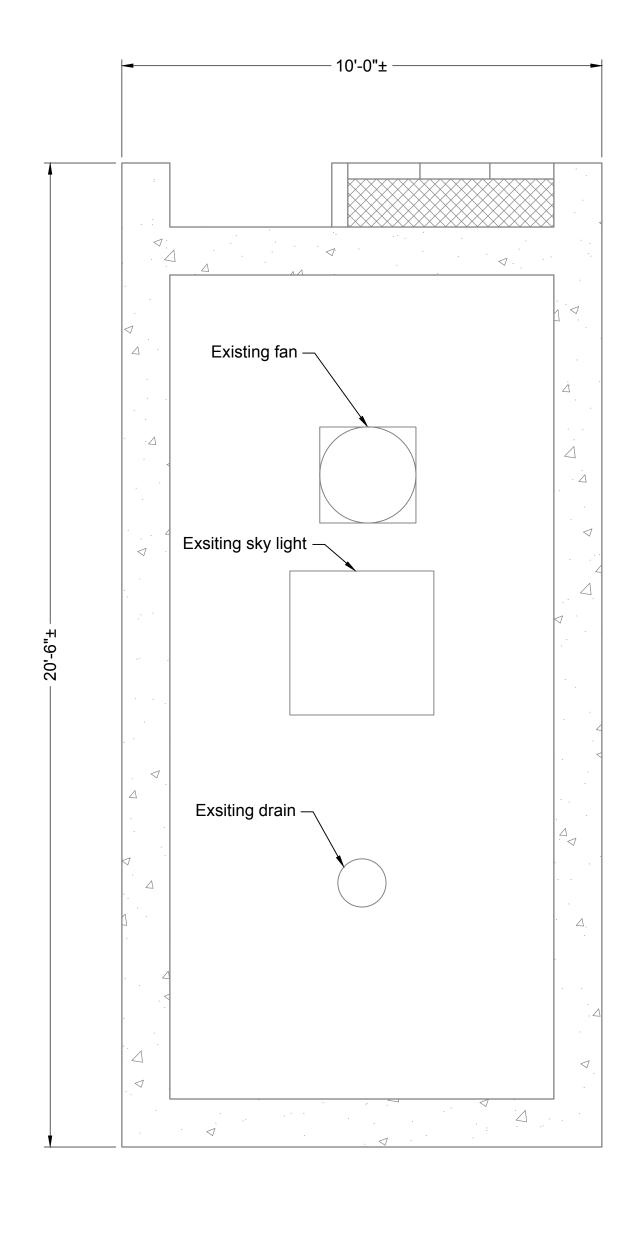



Middle

Note: Contractor to provide pre-approved siding material at gable ends of roofs, typ.

<u>Top view</u> Scale: 1/2" = 1'-0"

Roof Framing Plans
Scale: 1/2" = 1'-0"

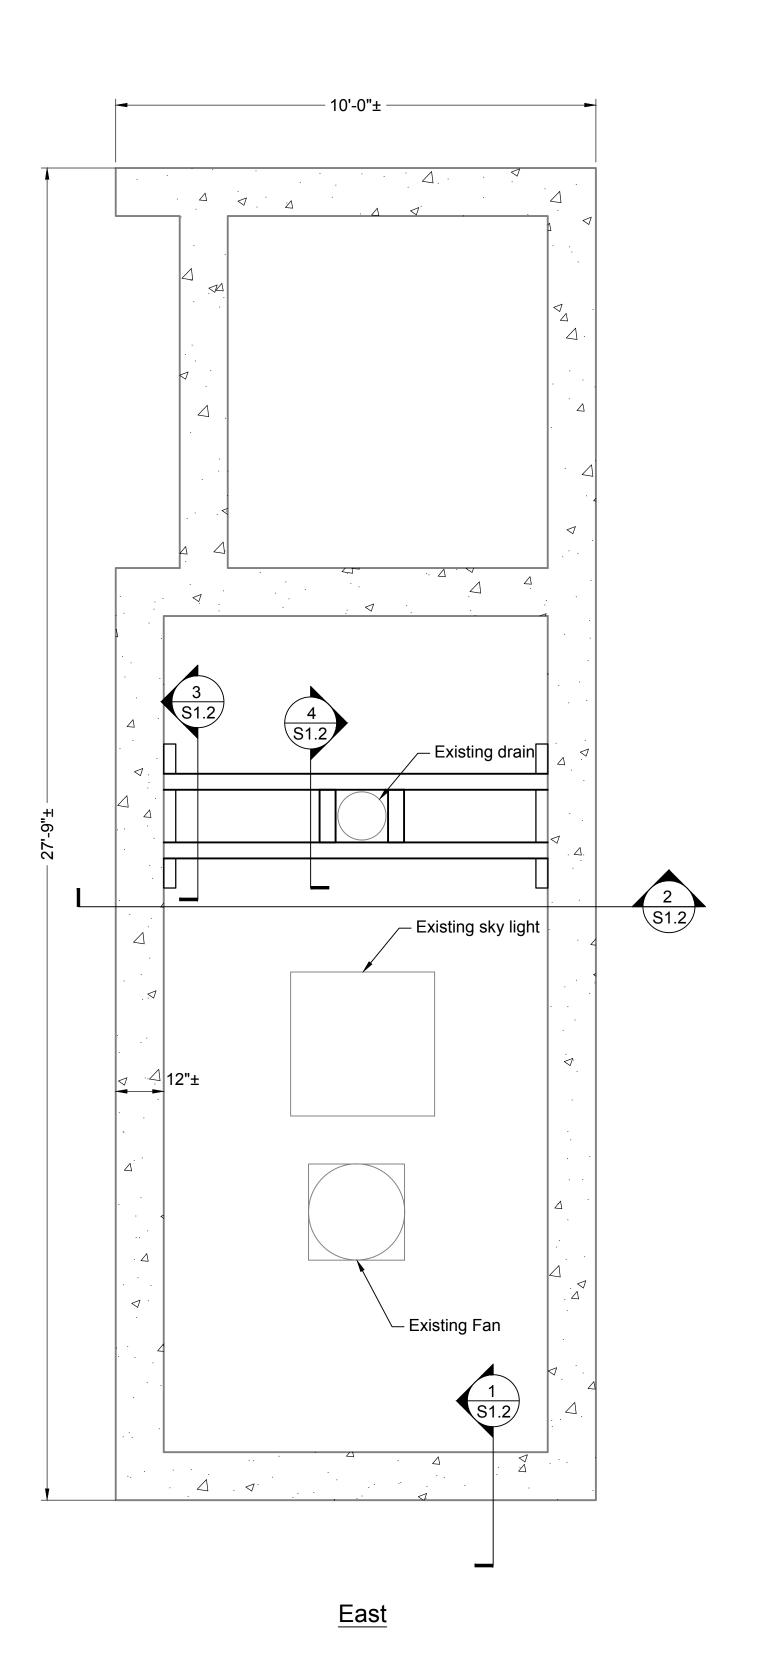


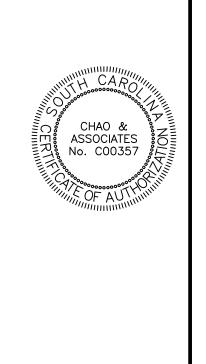

Parking Roof Framing Plan REBID - Blossom St. Park Stair Roof Repair Prepared for: University of South Carolir

Sheet Number April 8, 2019

Date

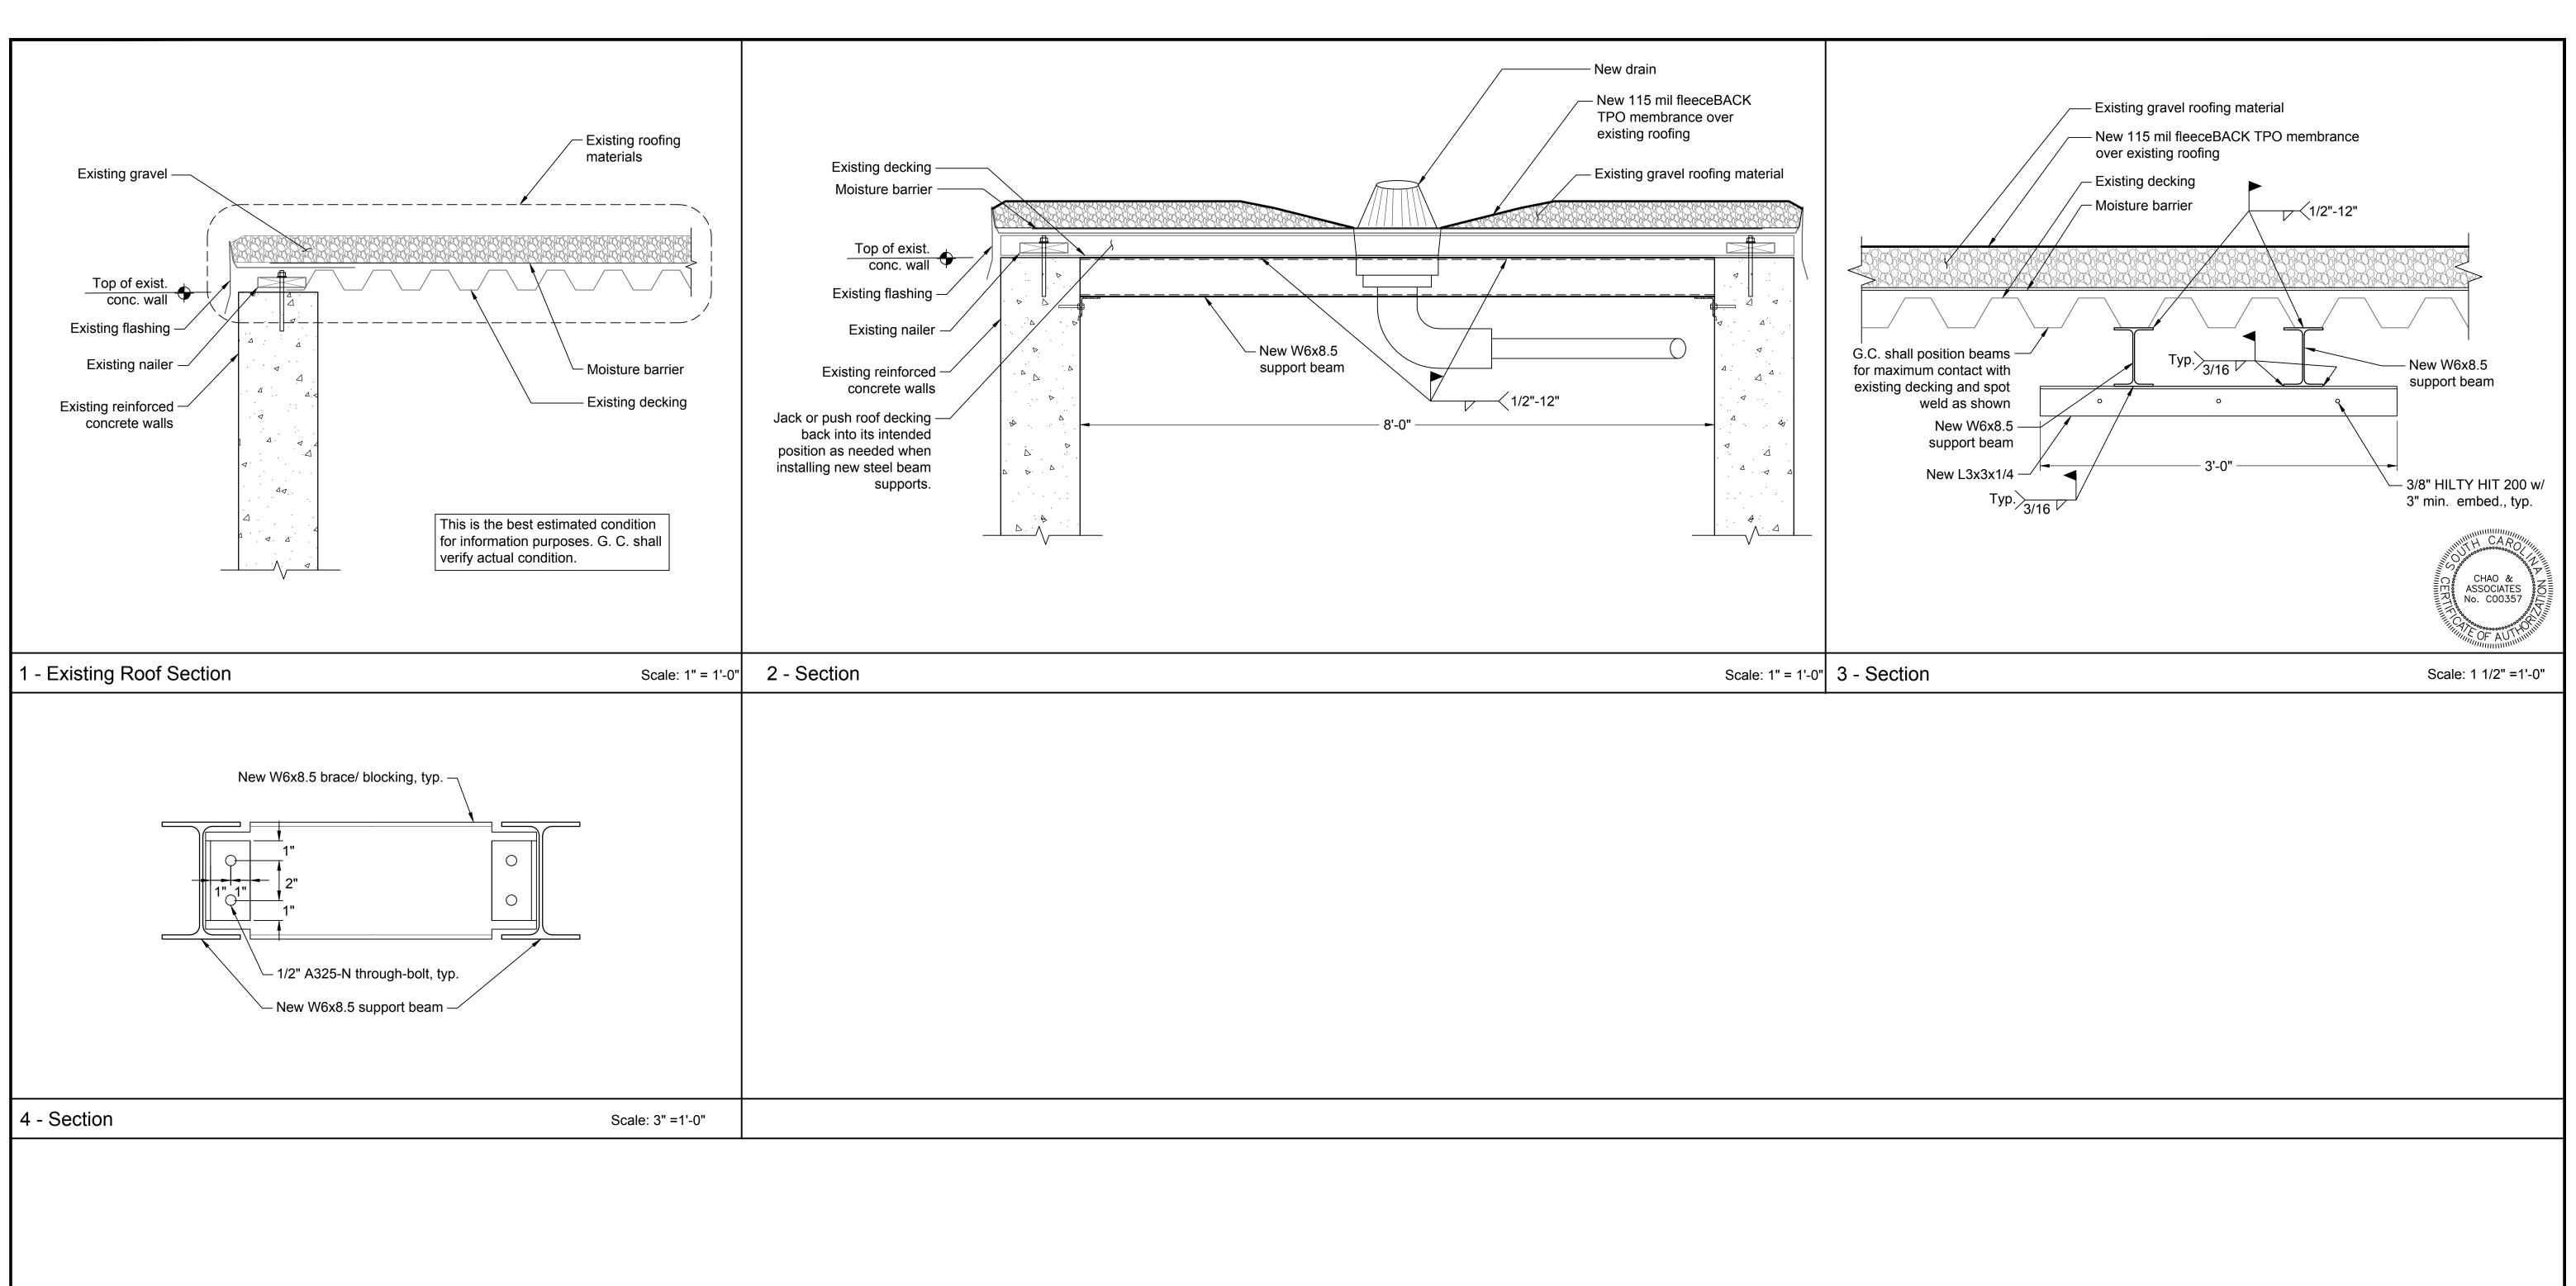



Civil - Structural - Survey
7 Clusters Court

SC

Columbia,

lina,

Garage r Sections and Details D - Blossom St. Parking C Roof Repair Ired for:

Sheet Number April 8, 2019